

- ROOF NOTES:**
1. ROOF TO BE CONSTRUCTED BY KNYSNA ROOFING
  2. PLEASE USE TRUSS SPACING PROVIDED ON DRAWING SO AS NOT TO INTERFERE WITH LIGHTING
  3. LAMINATE BEAM AND RAFTER STRUCTURE TO BE USED EVERYWHERE EXCEPT FOR CARPORT.
- PLUMBING NOTES:**
1. RING MAIN SYSTEM TO BE USED.

**Building Specifications and Schedule**

**GENERAL**

- 1.1 These building specifications and schedule of finishes contain information about the materials and finishes to be provided. Should any specified material and/or finish not be readily available at the Contractor's supplier(s) at the required time, then the closest readily available alternative will be selected and used by the Contractor and/or his agent(s).
- 1.2 All work in terms of Section 11(1) of the National Building Regulations and Building Standards Act (Act 103 of 1977, as amended), All work in this specification, unless otherwise specified, is for the account of the Contractor. All work also to be carried out in accordance with local authority building by-laws and regulations.
- 1.3 All work to conform with the National Energy Act No. 34 of 2008, The National Heritage Resources Act of 1999, The Consumer Protection Act No. 68 of 2008, The Promotion of Administrative Justice Act of 2000, The Access to Information Act No. 2 of 2000, The Architectural Professions Act no. 44 of 2000 and The Council for the Built Environment Act No. 43 of 2000.
- 1.4 It will be assumed that the Tenderers, before submitting a tender have acquainted themselves with the location of the site, access roads, existing services (both overhead and underground) and in general any risk contingency and other circumstances which may influence their tenders.
- 1.5 All construction details must comply to both the Architects details and NHBRC requirements.
- 1.6 This drawing is not to be scaled. Use figured dimensions only. All dimensions and heights to be checked and verified before any work commences on site. Any discrepancies to be reported to Simon Bebington Associates immediately. All levels, heights of ground, depths of excavations and number of stairs to be finally checked by the contractor on site.
- 1.7 The site to be treated in accordance with SABS code of practice No. 0124-1977 with "Shellidor" termite proof poisoner.
- 1.8 Stormwater to be removed from dwelling, yard and site.
- 1.9 Electrical installation shall be to registered electrician's specifications.
- 1.10 Simon Bebington Associates cannot be held responsible for information not provided through a copy of the registered title deeds regarding servitudes, restrictions, etc.
- 1.11 Fireplaces, Cold Rooms, Balustrading, Swimming Pools, Kitchens, Joinery and any other specialised work to be designed by the relevant specialists and to conform to SANS codes.
- 1.12 The contractor must conform with the Occupational Health and Safety Act No. 181 of 1993. The contractor will be responsible for OHS or alternatively must appoint a responsible person.

**ROOF**

- 2.1 Roofs to comply with Part - L of SANS - 10400.
- 2.2 Details and pitch as per working drawing.
- 2.3 Gutters and Downpipes to be Ogee profile extruded aluminium.
- 2.4 Timber construction to comply with SANS 082.

**WALLS**

- 3.1 All walls in accordance with Part - K of SANS - 10400.
- 3.2 Damp proof courses shall be provided and shall be 375 Micron "Gantle Brickgrip" or SANS 248.952 and 298 approved DPCs and lapped 150 mm at all angles and overlaps, under all walls, window sills and at changes in floor level.
- 3.3 Walls shall be built in clay bricks, bedded and jointed in class 2 cement mortar including all necessary expansion joints and brickwork every 6 courses and every 4 courses over openings.
- 3.4 Chimney to comply with Part V of SANS 10400 and NBR's.
- 3.5 All panework to comply with manufacturers specifications with necessary undercoats.
- 3.6 All openings more than 900mm to be provided with lintels.

**WINDOWS AND DOORS**

- 4.1 All glazing to comply with SANS 0137 and 1263 Part H of SANS 10400, NBR's & DTS rules for energy efficiency in glazing.
- 4.2 External window sills to be plastered, and to be sloped to falls externally.

**FLOORS AND SURFACE BED**

- 5.1 Floors to comply with Part - J of SANS 10400 and NBR's.
- 5.2 Floor finish as specified on plan.
- 5.3 All floors to comply with Part - J of SANS 10400 and NBR's.
- 5.4 Surface bed to be designed and constructed in accordance with Contractors Engineers Specification.
- 5.5 Concrete bed to be floated to a smooth finish to accept cement screed & floor covering.
- 5.6 Concrete surface bed to be on "Gumplas" USB Green damp proof membrane on sand binding well on well compacted fill.
- 5.7 Top of concrete surface bed to be a minimum of 150mm above finished ground level.

**FOUNDATIONS**

- 6.1 Foundations to be designed and constructed in accordance with Engineers Specification.
- 6.2 Floating raft or other approved as per Engineers specification and in accordance with Geo-technical Report.
- 6.3 All excavations to comply with Part - G of SANS 10400 and NBR's.
- 6.4 All foundations to comply with Part - H of SANS 10400 and NBR's.
- 6.5 Top of foundations to be a minimum of 300mm below finished ground level with backfill to all foundations.

PROJECT **PROPOSED NEW HOUSE FOR MR & MRS GURNEY ON ERF 3928**  
**SOLAR BEACH PLETTENBERG BAY**

DESCRIPTION **GROUND FLOOR PLAN**

SCALE: 1:50

REV	DATE	REVISION	NAME
1	2018.03.06	REVISED TO REMOVE GRANNY FLAT	SIMON

DRAWN	SIMON	DWG NO	3928-01
DATE	2018.03.12	PUMP NO	3928-2018-07

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AREA SCHEDULE	NEW
GROUND FLOOR	208.38m <sup>2</sup>
CARPORT COVERED	49.18m <sup>2</sup>
GRAND TOTAL COVERED AREA	257.56m <sup>2</sup>
SITE AREA	782.13m <sup>2</sup>
TOTAL COVERAGE	257.56m <sup>2</sup>
COVERAGE PERCENTAGE	32.93%

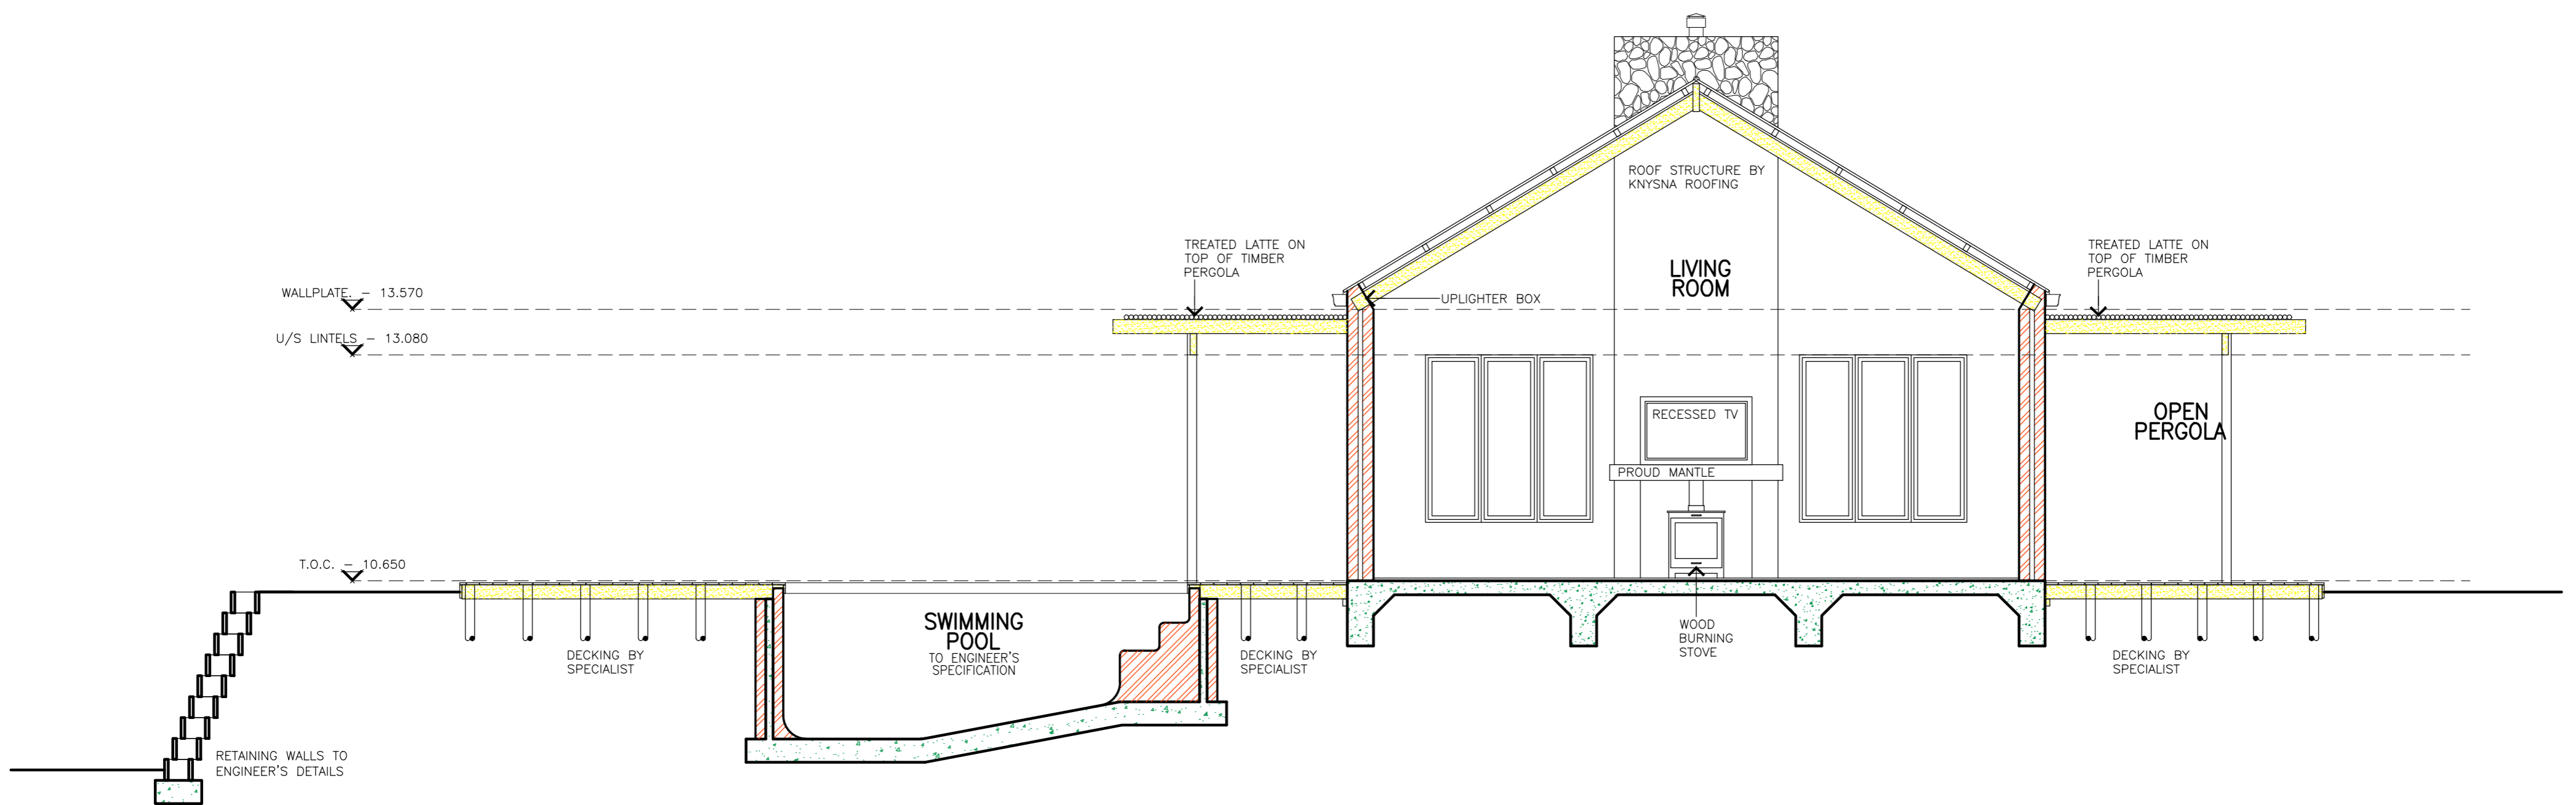
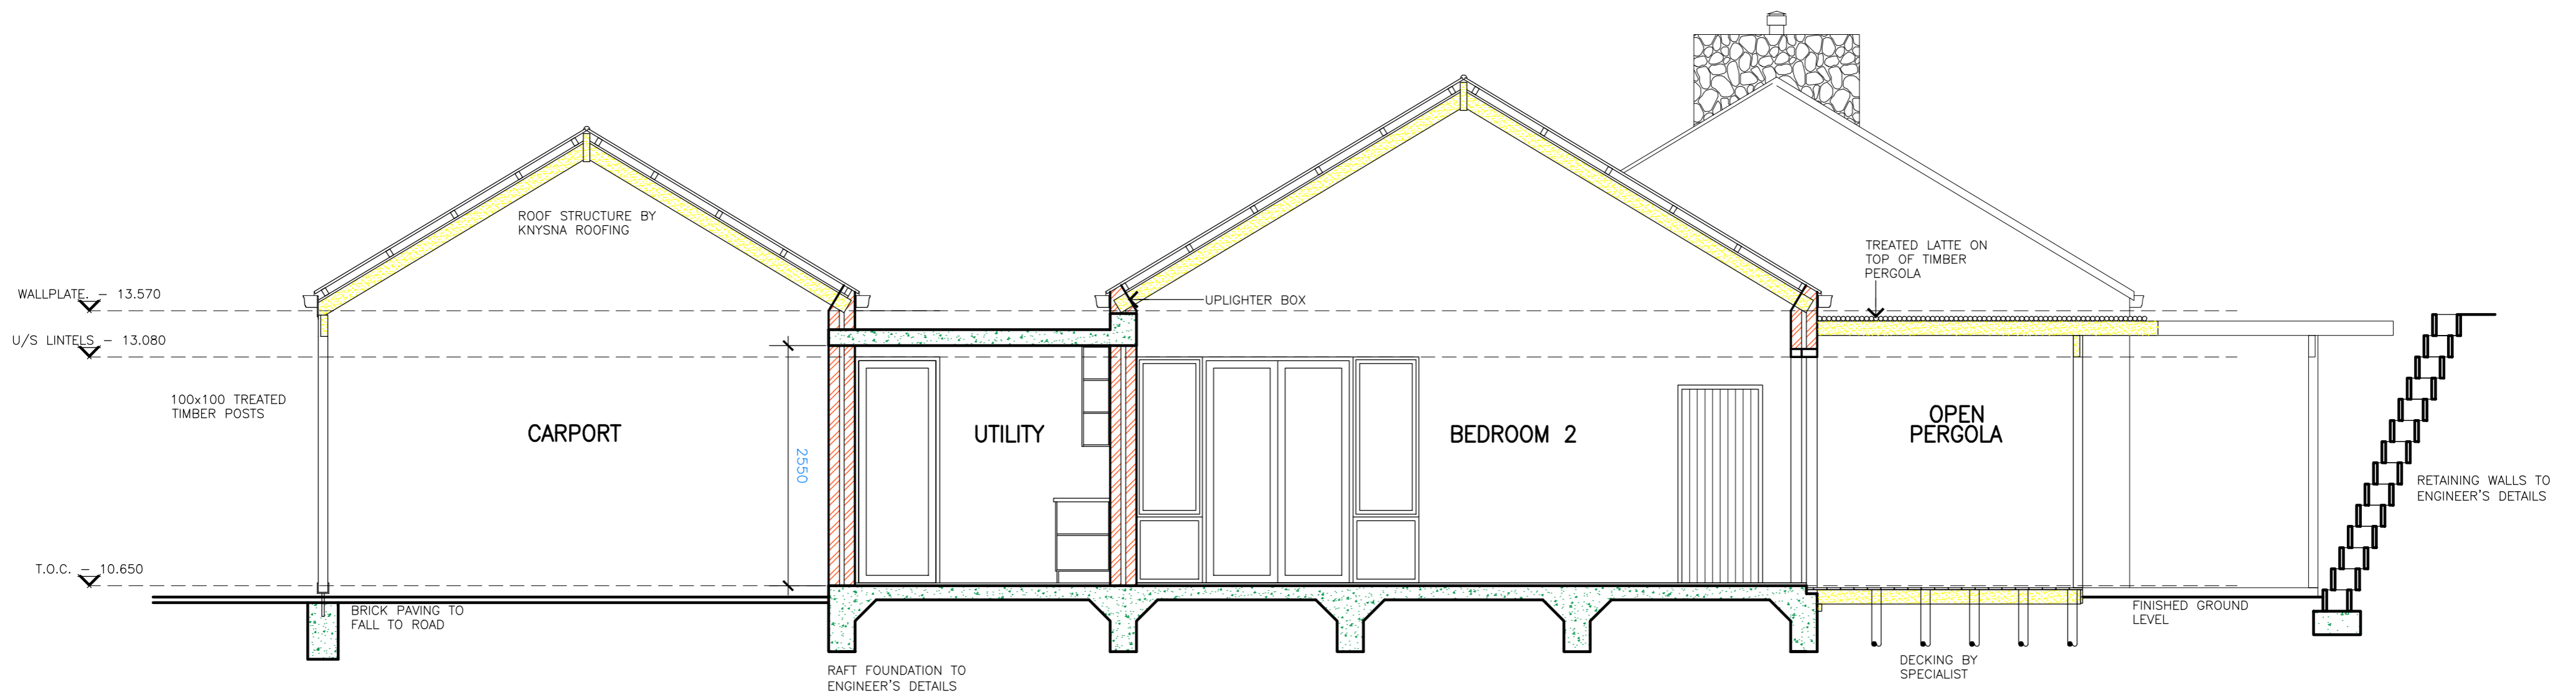
OWNER \_\_\_\_\_ DATE \_\_\_\_\_

S.R. ARCH \_\_\_\_\_ SACAP reg no. ST1135 DATE \_\_\_\_\_

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**ARCHITECTURE**

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**Project Details**

New House Gurney Erf 3928 Solar Beach Plettenberg Bay

Creation Date:	March 15, 2018, 8:27 a.m.	Achieved	Target
Floor Level:	1	Nett Glazed Area	72.26 m <sup>2</sup> 36.13 %
Nett Floor Area:	200	Solar Heat Gain	13.59 26.00
Climate Zone:	Zone 4 Temperate coastal	Conductance	277.04 280.00
Solar Heat Gain Constant (CSHG):	0.13		
Conductance Constant (CU):	1.4		

**Windows**

Description	Qty	Width (m)	Height (m)	Glass Product	Frame Material	Total Area (m <sup>2</sup> )	PH	SHGC Glazing	SHGC Proposed	U-value	Total U-value
						72.26 m				13.59	277.04
D-1 (glazing/windows/837)	1	1.6	2.4	X2 Armourplate Low E & Clearvue	Primador Hinged Doors (SG/DG)	3.84	0.91	0.64	0.00	3.76	14.44
D-2 (glazing/windows/838)	1	3.0	2.4	X2 Armourplate Low E & Clearvue	Primador Hinged Doors (SG/DG)	7.20	1.06	0.64	0.00	3.76	27.07
D-3 (glazing/windows/839)	1	3.83	2.4	X2 Armourplate Low E & Clearvue	Primador Stacking Door (SG/DG)	9.19	0.94	0.64	1.53	3.76	34.56
D-4 (glazing/windows/840)	1	3.83	2.4	X2 Armourplate Low E & Clearvue	Primador Stacking Door (SG/DG)	9.19	1.04	0.64	1.53	3.76	34.56
D-5 (glazing/windows/841)	1	3.0	2.4	X2 Armourplate Low E & Clearvue	Primador Hinged Doors (SG/DG)	7.20	0.08	0.64	2.90	3.76	27.07
D-6 & 7 (glazing/windows/842)	2	3.0	2.4	X2 Armourplate Low E & Clearvue	Primador Hinged Doors (SG/DG)	14.40	1.34	0.64	2.12	3.76	54.14
D-8 (glazing/windows/843)	1	0.9	2.4	X2 Armourplate Low E & Clearvue	Primador Hinged Doors (SG/DG)	2.16	0.08	0.64	0.00	3.76	8.12
W-1 & 2 (glazing/windows/844)	2	1.2	1.8	X2 Armourplate Low E & Clearvue	Primador Casement 38mm (SG/DG)	4.32	0.11	0.64	1.74	4.04	17.45
W-3, 8 & 9 (glazing/windows/845)	3	1.2	1.8	X2 Armourplate Low E & Clearvue	Primador Casement 38mm (SG/DG)	6.48	0.51	0.64	0.00	4.04	26.18
W-4 (glazing/windows/846)	1	0.6	1.2	X2 Armourplate Low E & Clearvue	Primador Casement 38mm (SG/DG)	0.72	0.17	0.64	0.22	4.04	2.91
W-5 (glazing/windows/847)	1	0.6	1.2	X2 Armourplate Low E & Clearvue	Primador Casement 38mm (SG/DG)	0.72	1.92	0.64	0.00	4.04	2.91
W-6 (glazing/windows/848)	1	0.9	0.6	X2 Armourplate Low E & Clearvue	Primador Casement 38mm (SG/DG)	0.54	0.33	0.64	0.15	4.04	2.18
W-7 (glazing/windows/849)	1	1.2	1.5	X2 Armourplate Low E & Clearvue	Primador Casement 38mm (SG/DG)	1.80	0.13	0.64	0.62	4.04	7.27
W-10 (glazing/windows/850)	1	1.8	1.5	X2 Armourplate Low E & Clearvue	Primador Casement 38mm (SG/DG)	2.70	0.13	0.64	1.75	4.04	10.91
W-11 (glazing/windows/851)	1	0.6	1.2	X2 Armourplate Low E & Clearvue	Primador Casement 38mm (SG/DG)	0.72	0.17	0.64	0.41	4.04	2.91
W-12 (glazing/windows/852)	1	0.9	1.2	X2 Armourplate Low E & Clearvue	Primador Casement 38mm (SG/DG)	1.08	0.17	0.64	0.62	4.04	4.36
						72.26 m <sup>2</sup>				13.59	277.04

GLAZING NOTES:  
1. PLEASE NOTE GLAZING TYPE REQUIRED EG. DOUBLE GLAZING

**INSULATION NOTES:**

WALLS:  
CAVITY WALL CONSTRUCTION TO COMPLY WITH REQUIRED 1.9 R-VALUE.

ROOF ASSEMBLY (OPEN TRUSS UNDER SHEET ROOF):  
MINIMUM REQUIRED TOTAL R-VALUE = 3.70  
CATHEDRAL CEILING 22-45° PITCH, SHEET ROOF = 0.40  
PROVIDE 50mm AEROLITE INSULATION = 1.25  
SISALATION ROOF SHEETING UNDERLAY = 1.36  
16mm TIMBER CEILING = 0.80  
TOTAL R-VALUE = 3.81 of REQUIRED 3.70

ROOF ASSEMBLY (CONCRETE SLAB):  
MINIMUM REQUIRED TOTAL R-VALUE = 3.70  
170mm CONCRETE SLAB WITH MIN. 30mm CEMENT SCREED = 0.14  
WATERPROOF MEMBRANE = 0.03  
PROVIDE 120mm EXPANDED POLYSTYRENE = 3.70 (DEEMED TO SATISFY)  
TOTAL R-VALUE = 3.87 of REQUIRED 3.70

WATER HEATER:  
PROVIDE A 200L GEYSER WITH A SANS 10400XA COMPLIANT HEAT PUMP  
ENERGY DEMAND:  
ALLOWED 5W/m<sup>2</sup>  
NEW FLOOR AREA 250m<sup>2</sup> x 5W/m<sup>2</sup> = 1250W  
28 x 11W LAMPS = 208W  
28 x 7W LED LAMPS = 196W  
TOTAL = 404W OF ALLOWED 1250W

PROJECT **PROPOSED NEW HOUSE FOR MR & MRS GURNEY ON ERF 3928 SOLAR BEACH PLETTENBERG BAY**  
DESCRIPTION **SECTION A-A AND SECTION B-B**

SCALE: 1:50

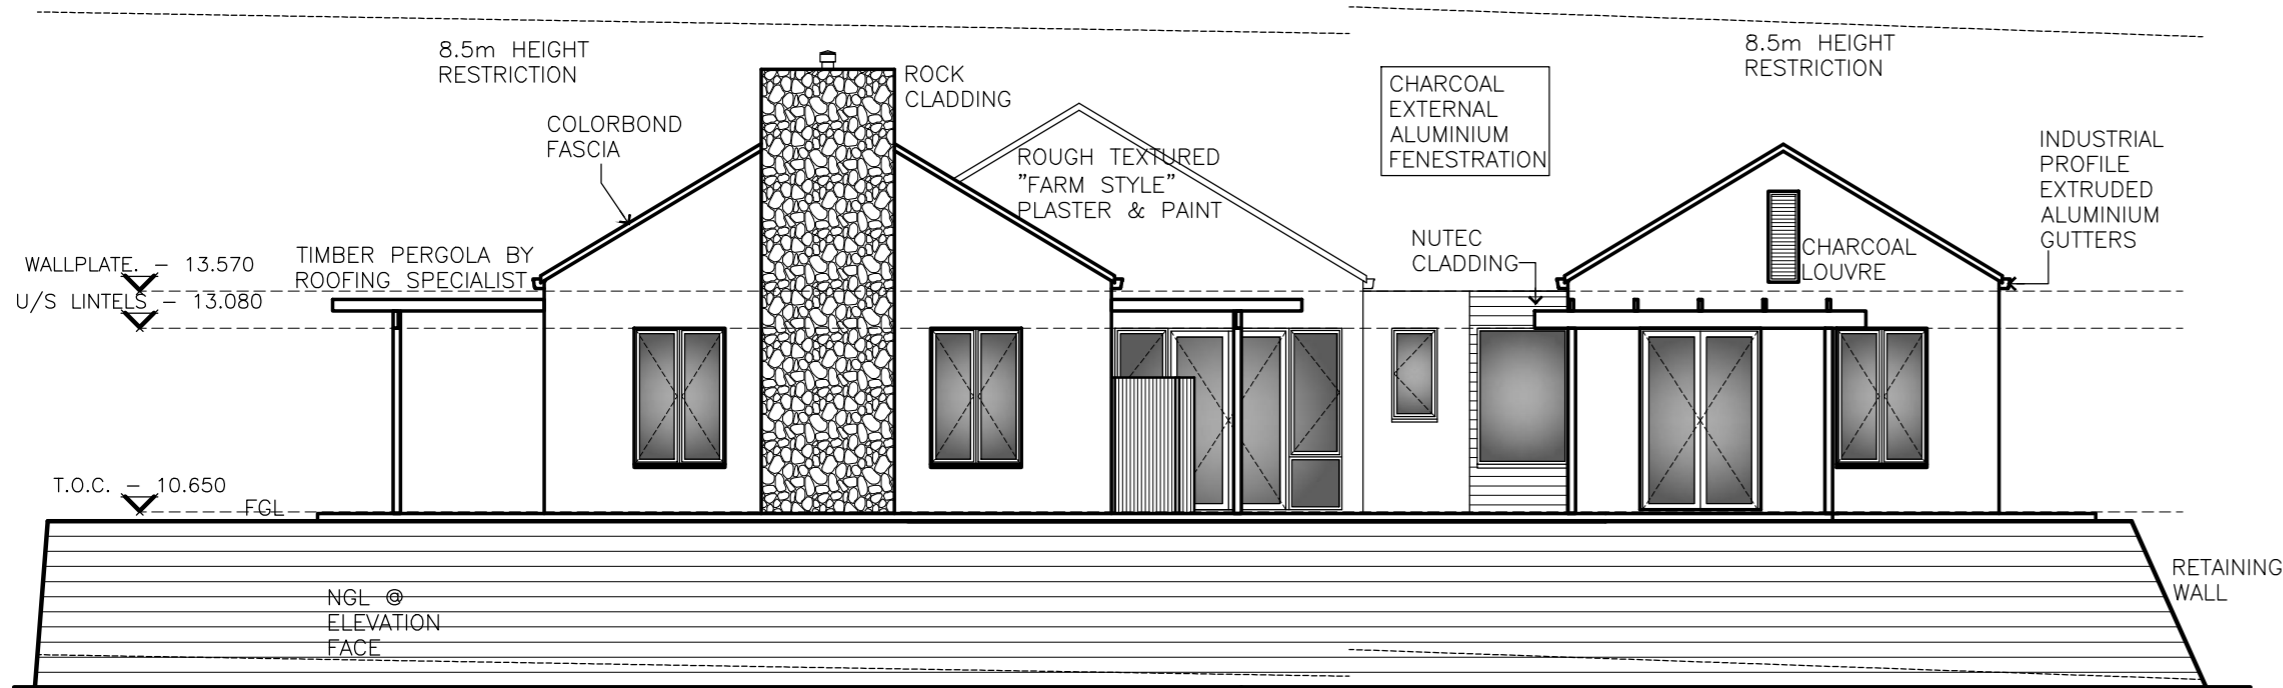
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1	2018.06.06	REVISED TO REMOVE GRANNY FLAT	SIMON

DRAWN **SIMON** DATE **2018.03.12** DWG NO **3928-02** COMP NO **3928 - 2018-07**

OWNER \_\_\_\_\_ DATE \_\_\_\_\_  
S.B. ARCH \_\_\_\_\_ SACAP reg no. ST1135. DATE \_\_\_\_\_

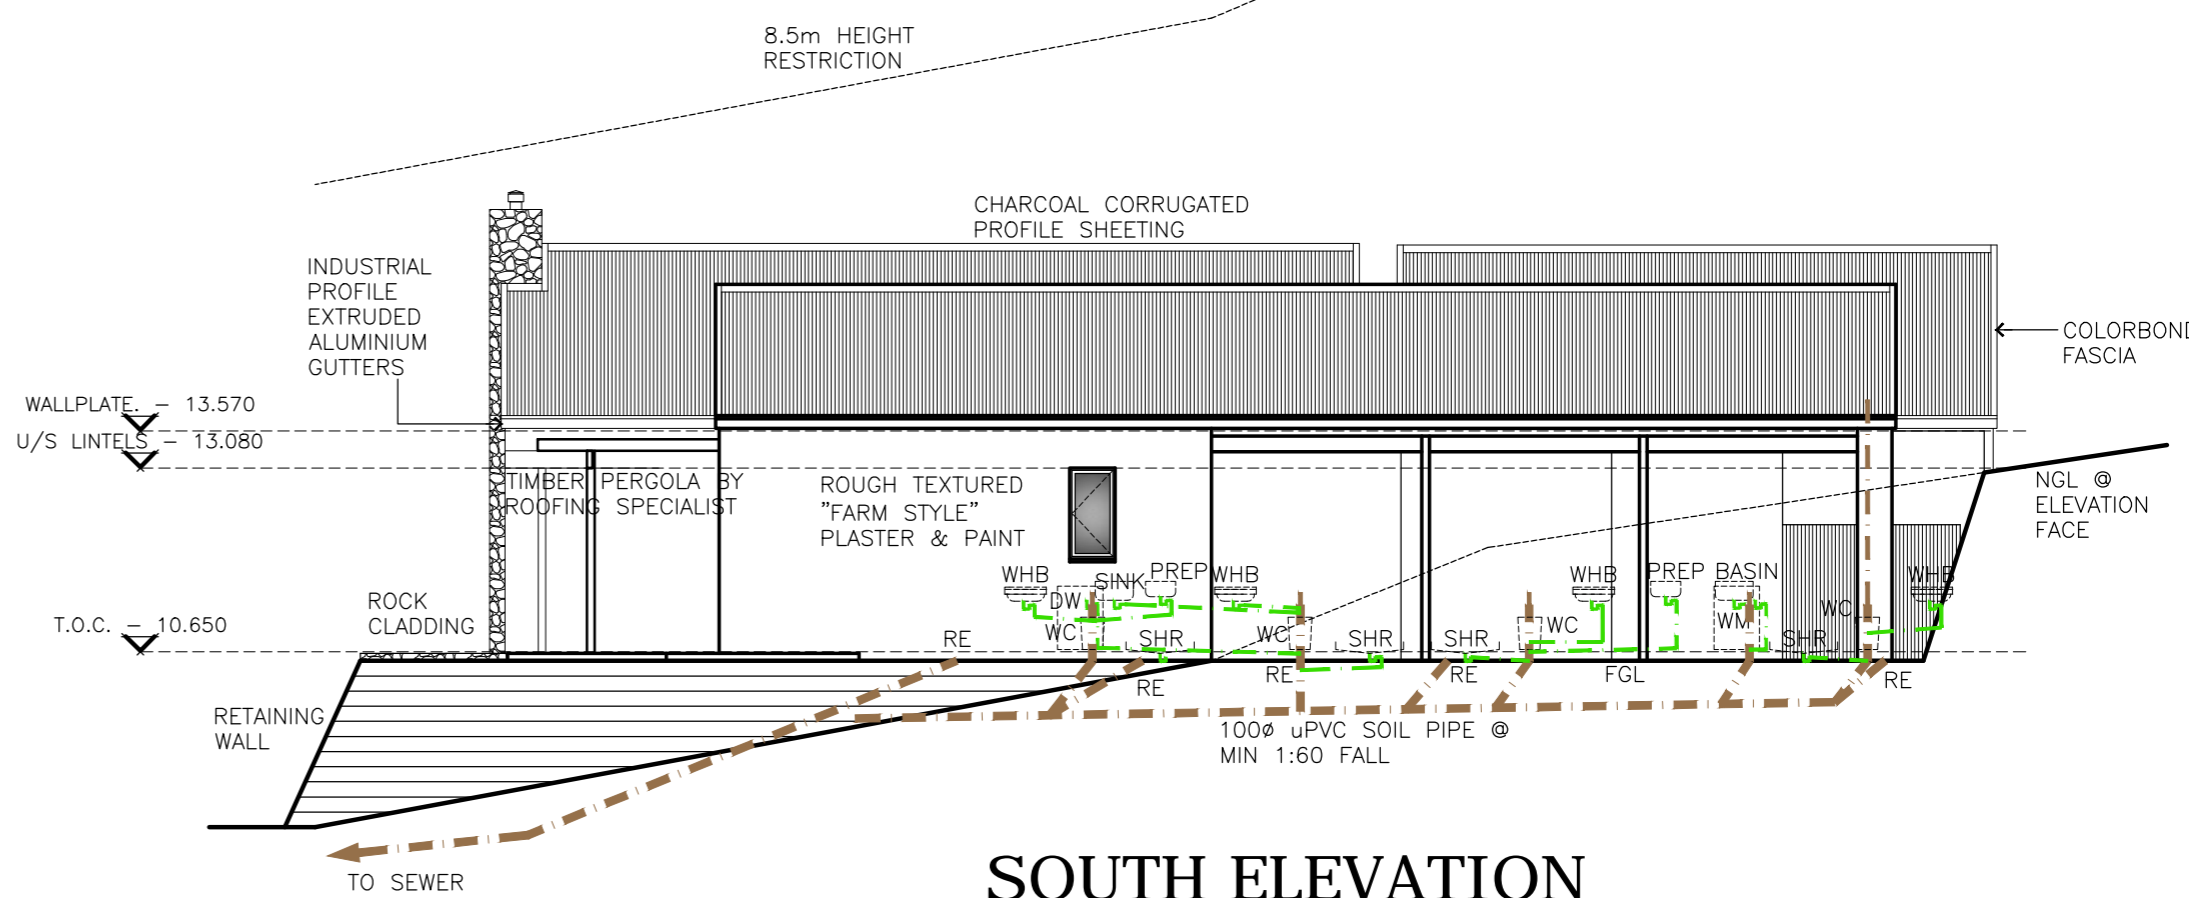


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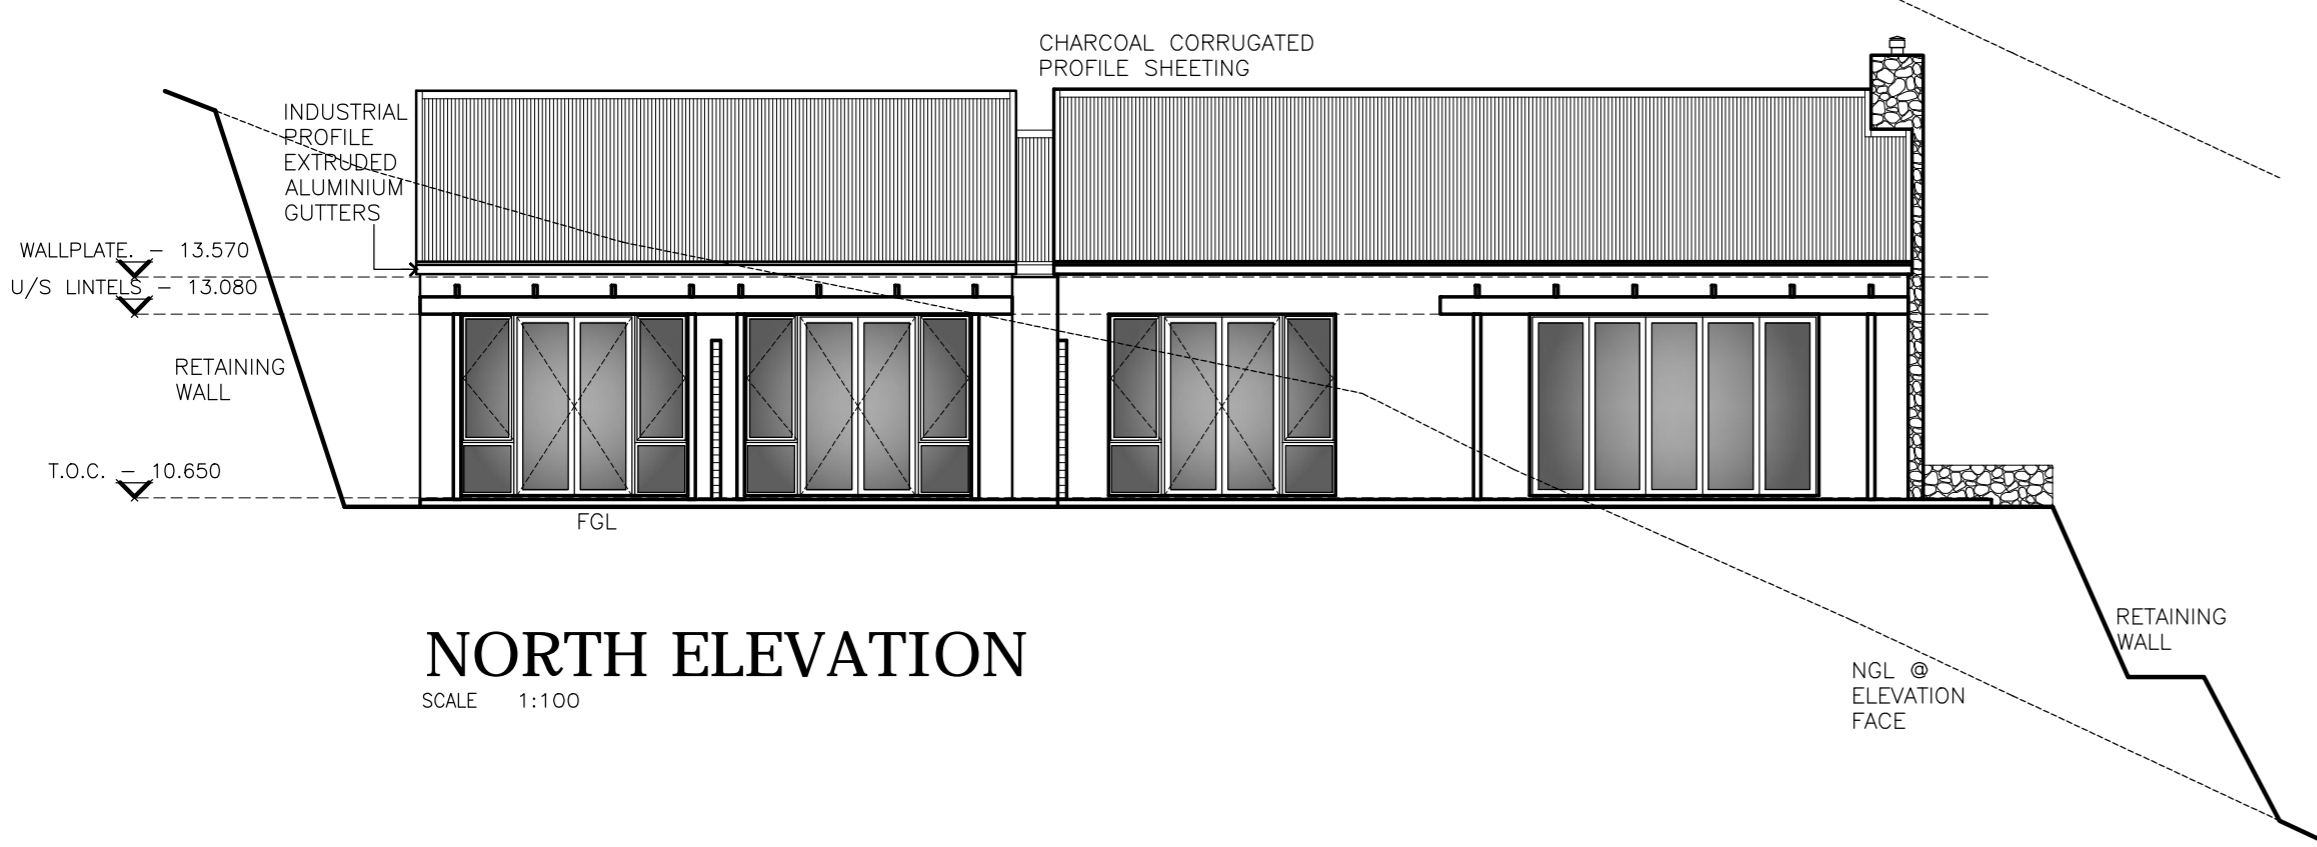
**WEST ELEVATION**

SCALE 1:100



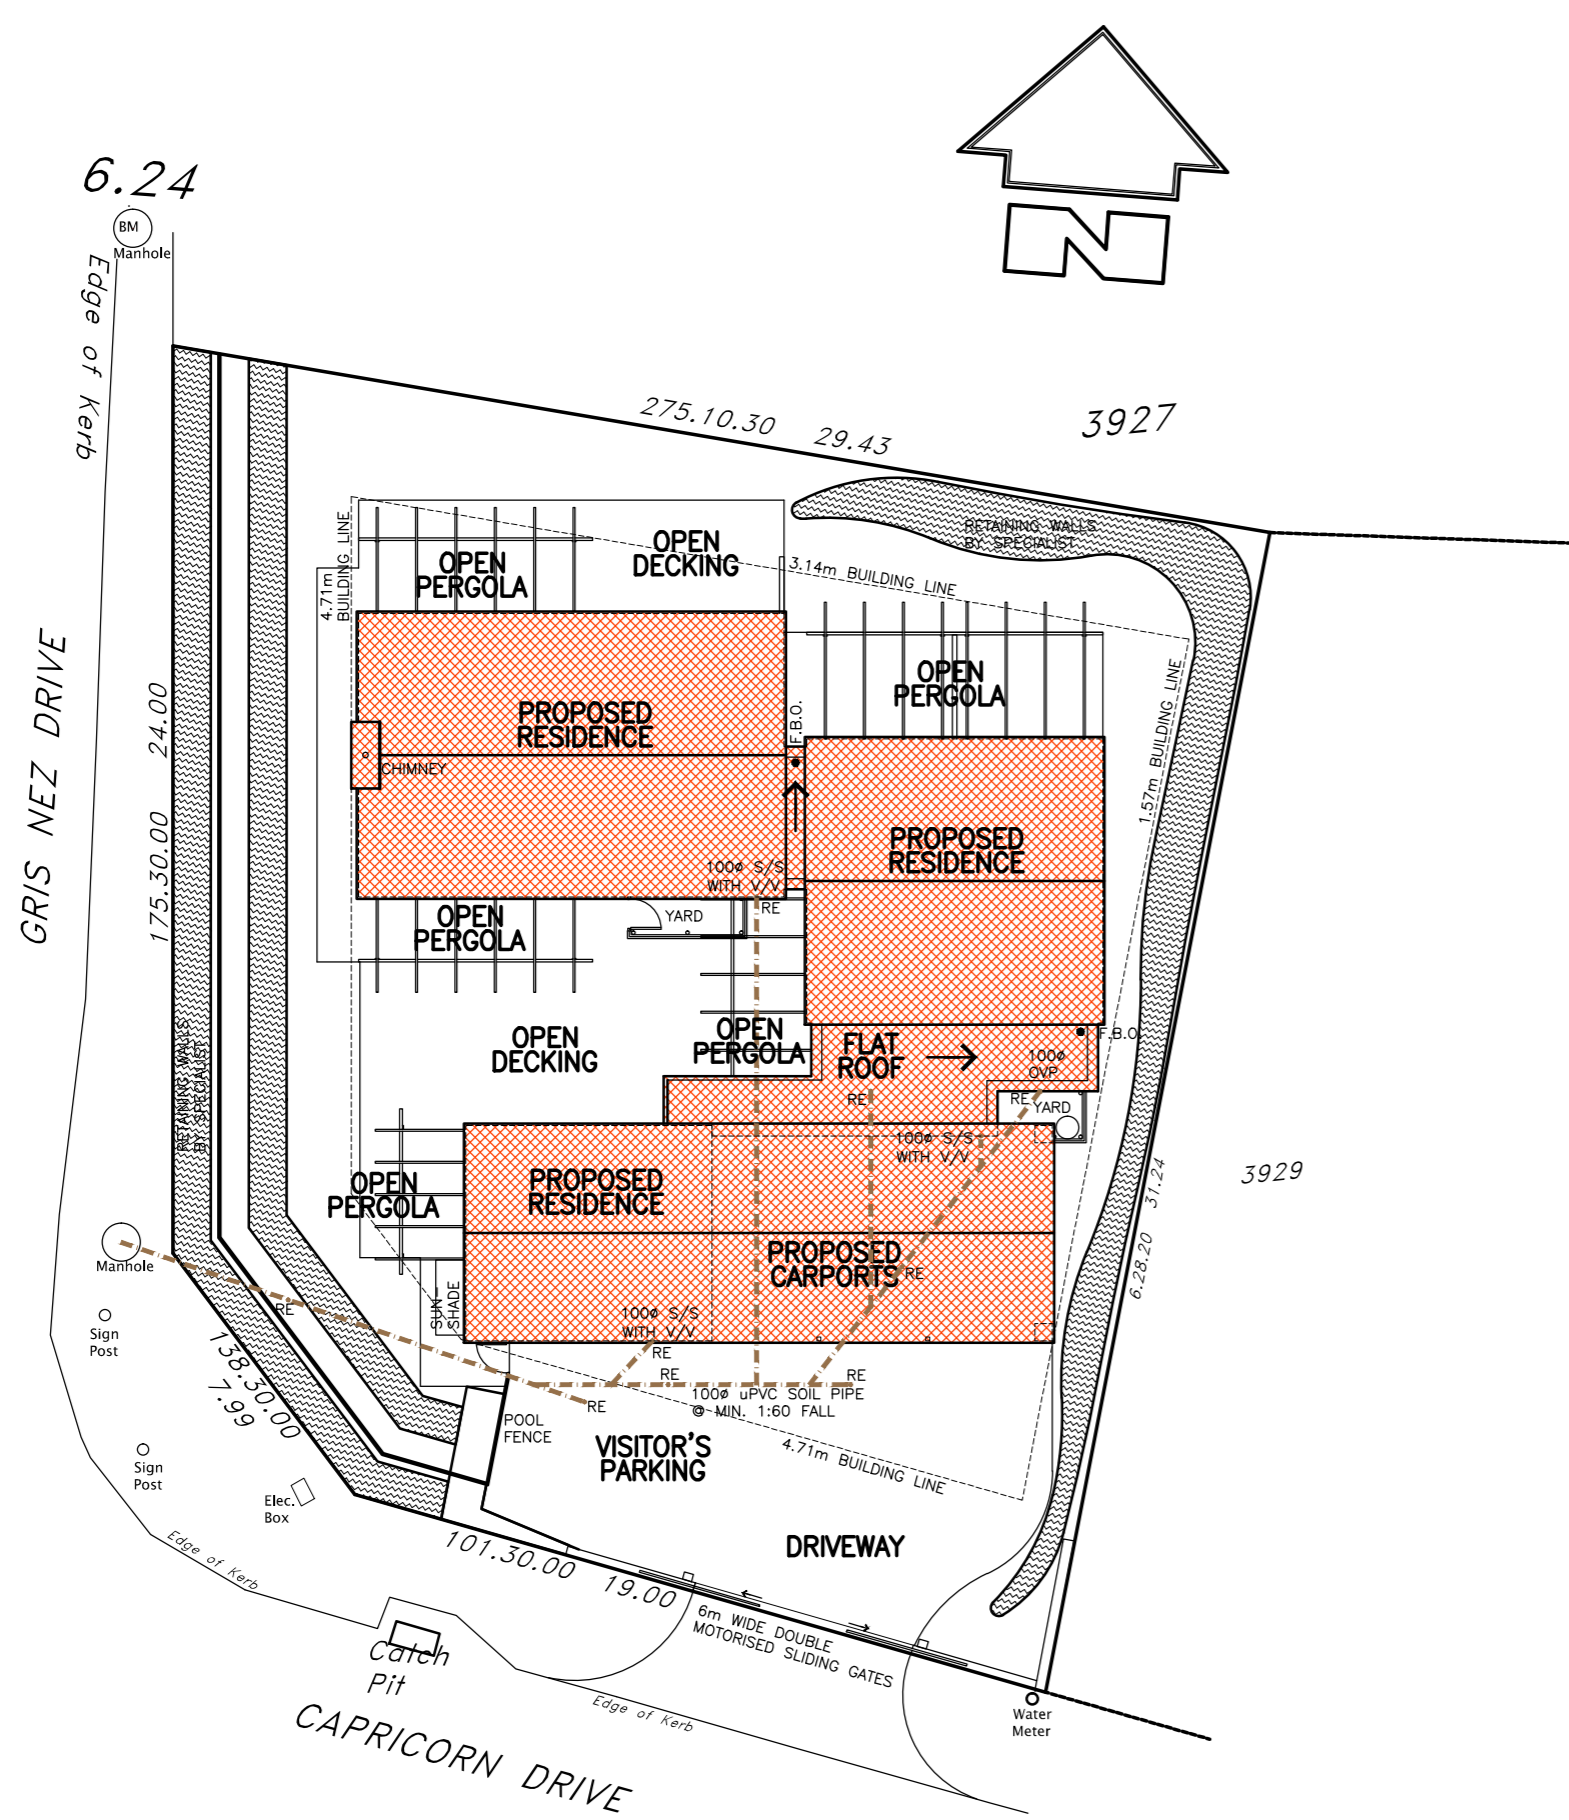
**SOUTH ELEVATION**

SCALE 1:100



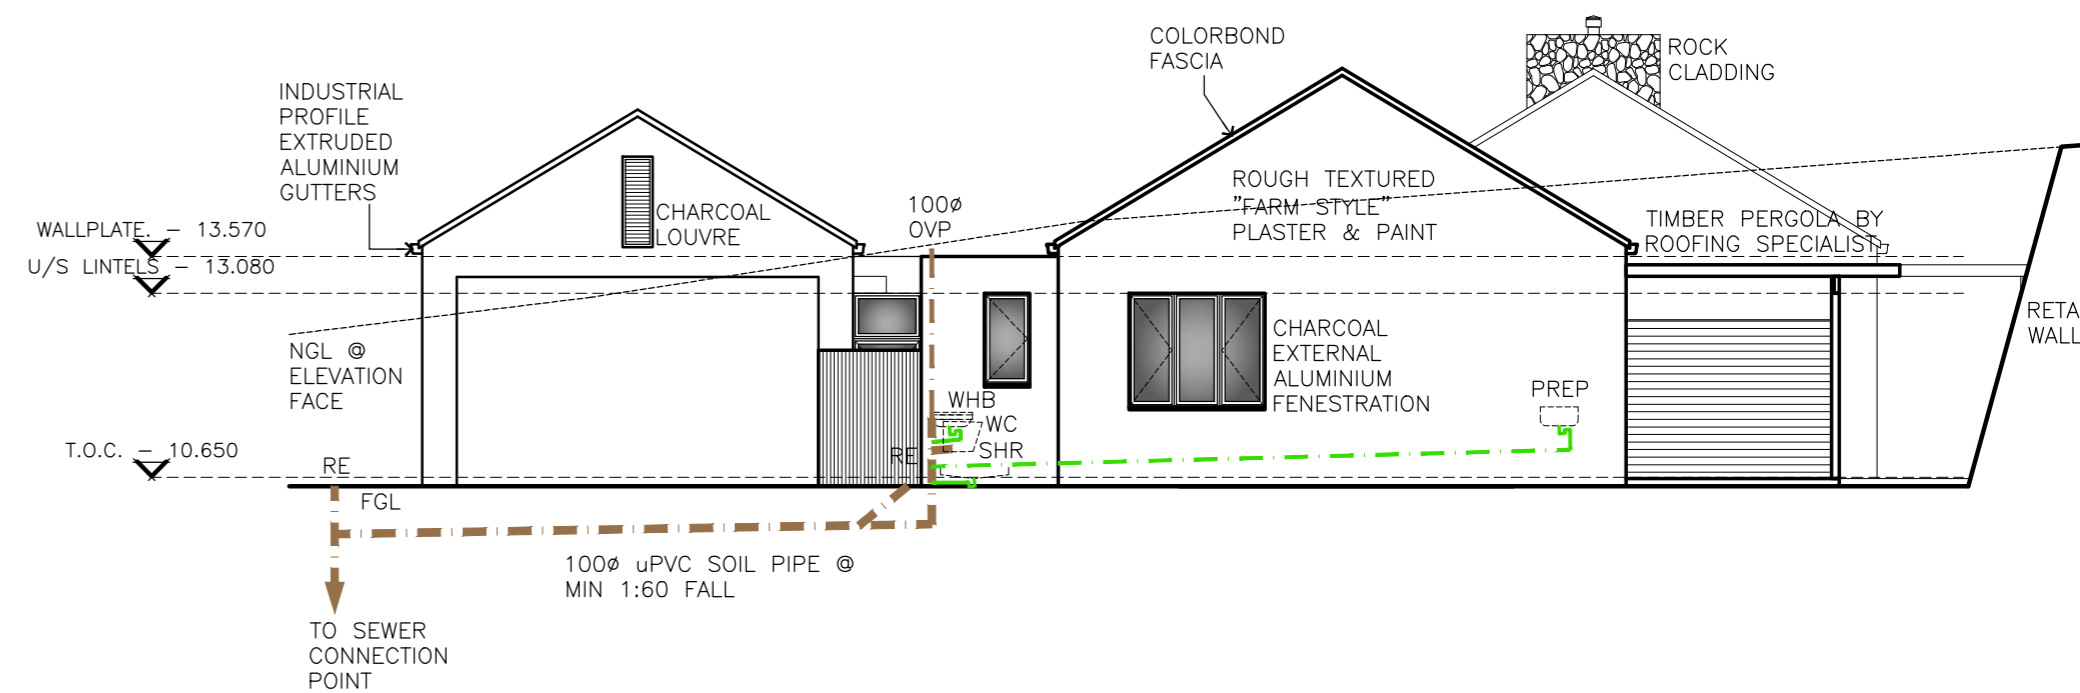
**NORTH ELEVATION**

SCALE 1:100



**SITE PLAN**

SCALE 1:200



**EAST ELEVATION**

SCALE 1:100

PROJECT **PROPOSED NEW HOUSE FOR MR & MRS GURNEY ON ERF 3928 SOLAR BEACH PLETTENBERG BAY**

DESCRIPTION **ELEVATIONS AND SITE PLAN**

SCALE: **AS SHOWN**

OWNER \_\_\_\_\_ DATE \_\_\_\_\_  
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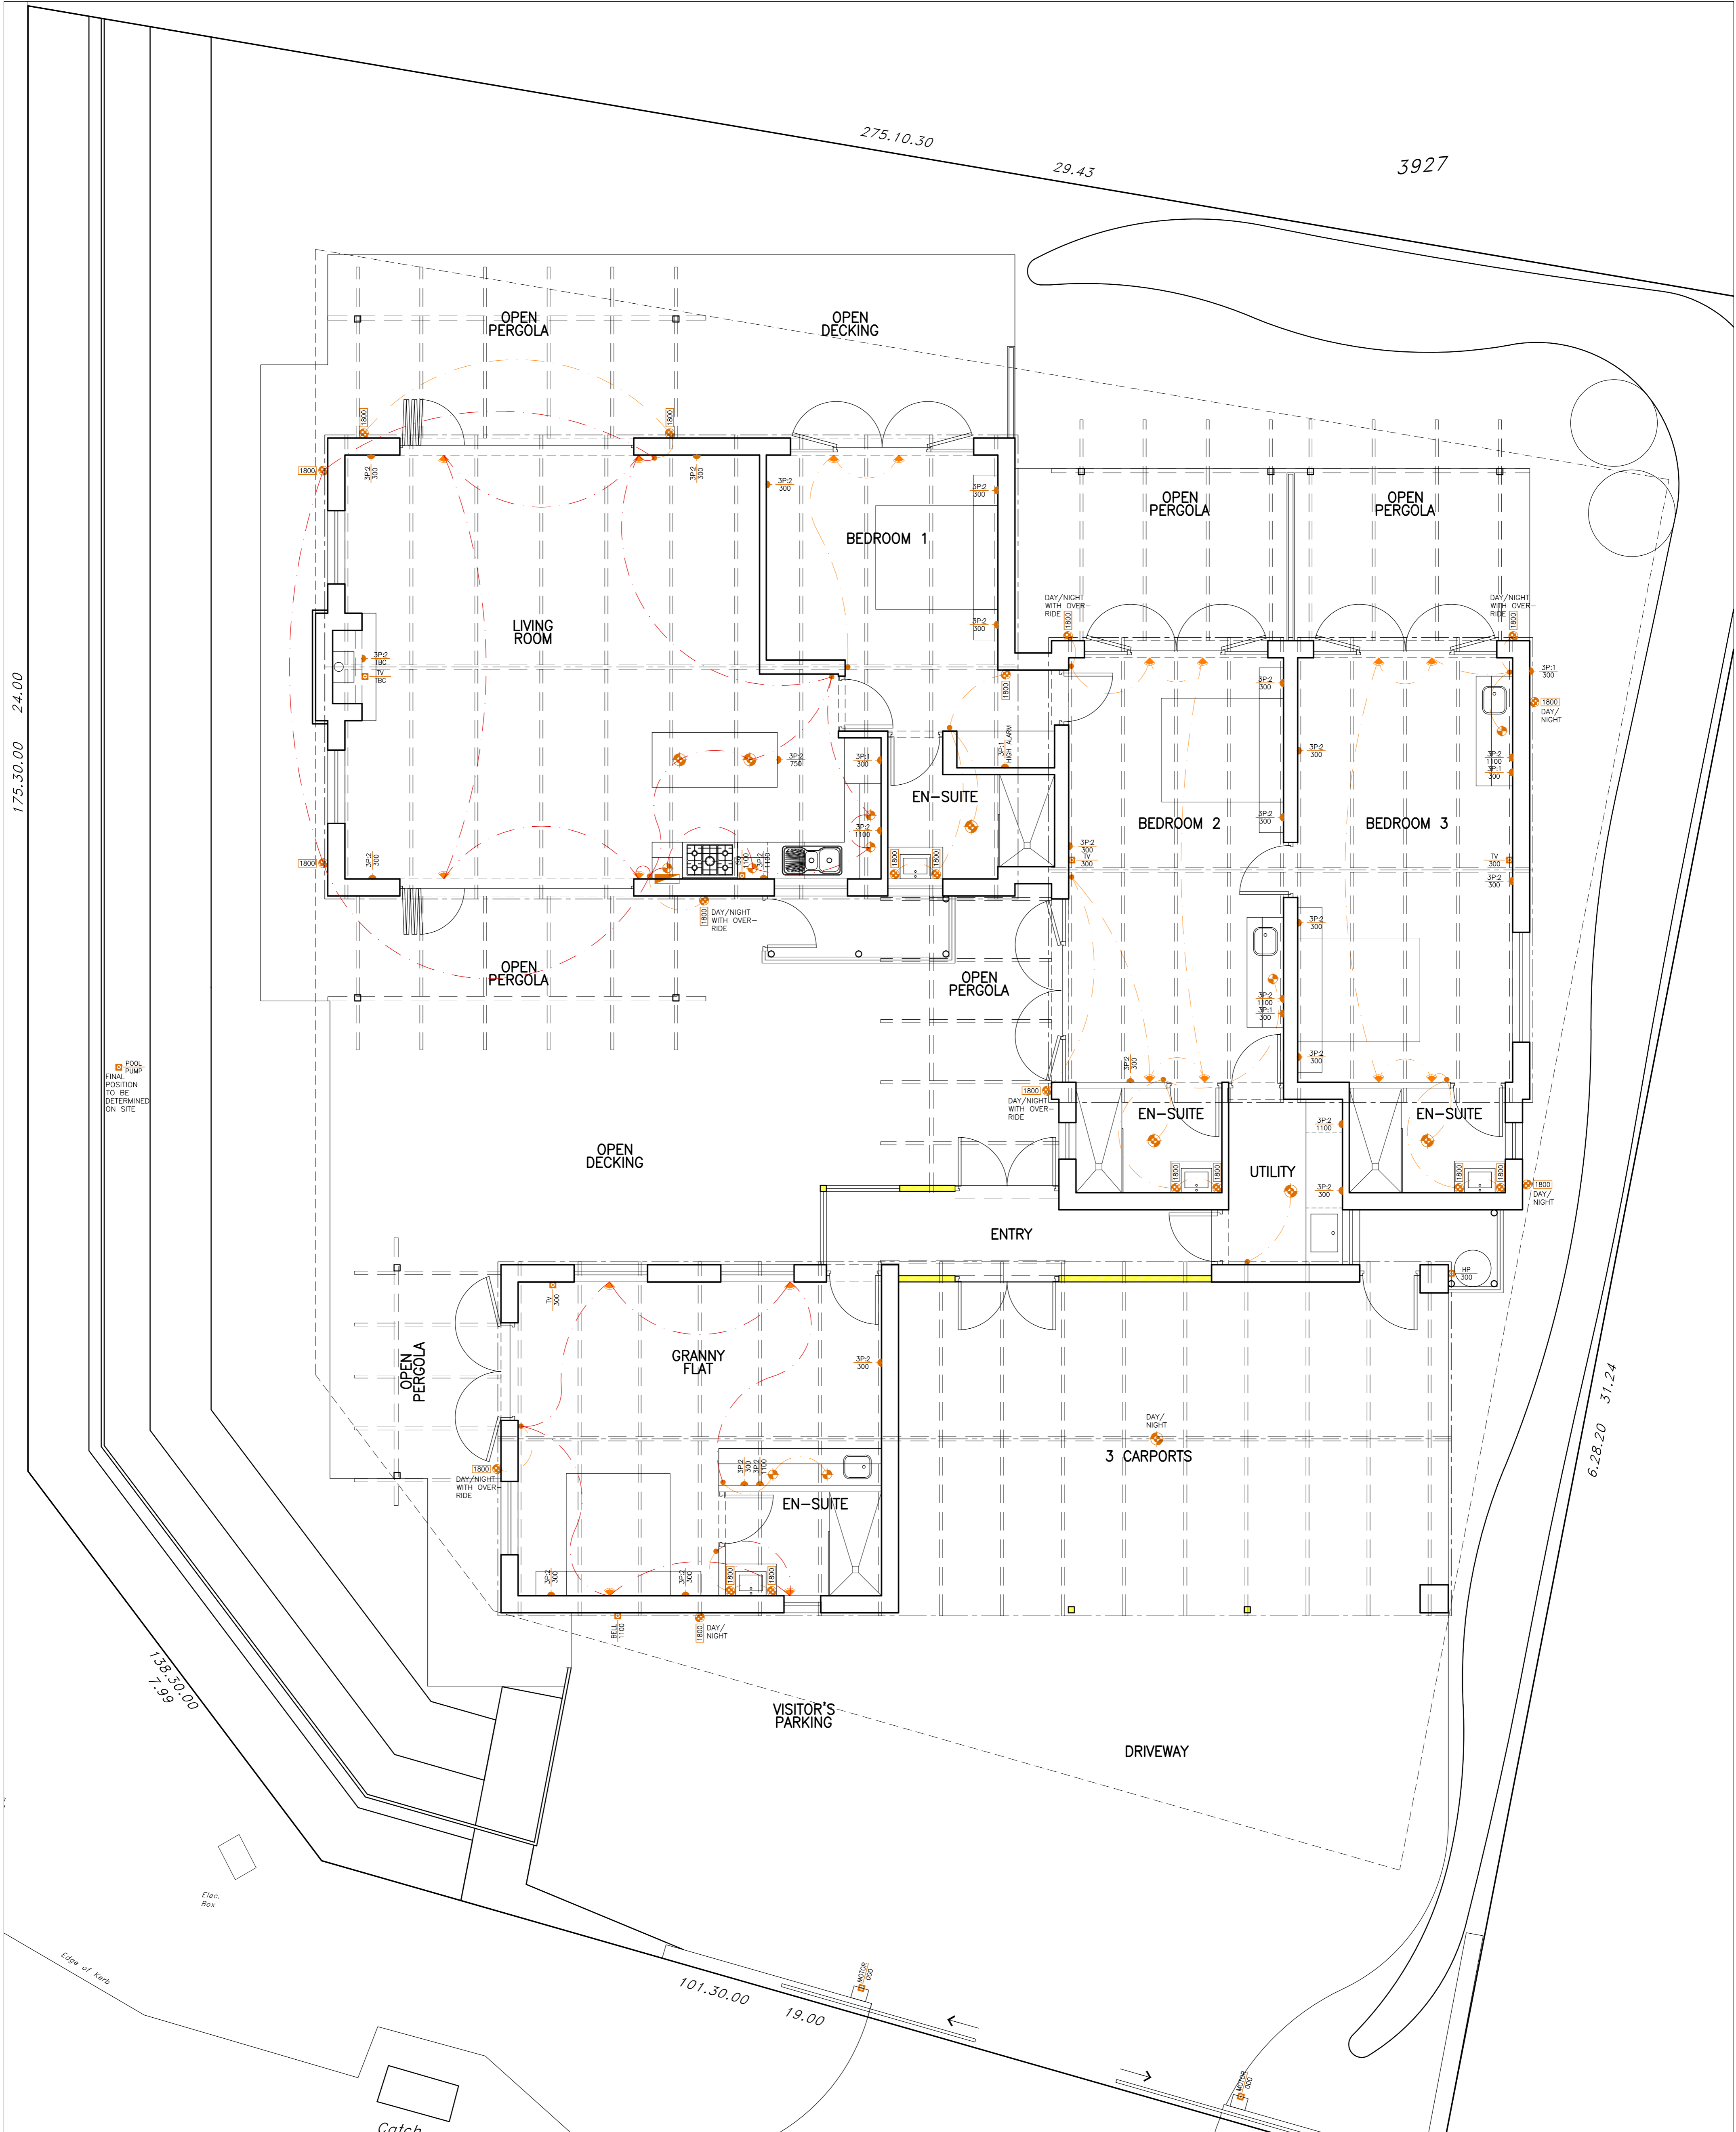
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1	2018.06.06	REVISED TO REMOVE GRANNY FLAT	SIMON

**Simon Bebington**  
**ARCHITECTURE**

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DATE **2018.03.12** COMP NO **3928 - 2018-07**

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**ELECTRICAL LEGEND**

●	LIGHT SWITCH
3P-2 300	15 AMP 3 PRONG PLUG POINT, CENTRE HEIGHT AFFL INDICATED TO LEFT, NO. OF 3 PRONG PLUGS INDICATED TO RIGHT
BELL 300	ELEC POINT KEY: ISO - ISOLATOR SWITCH; BELL - DOOR BELL; TV - DSTV CONN; TEL - TELEPHONE; HP - HEAT PUMP
◆	L.E.D. DOWNLIGHTER OR UNDER COUNTER LIGHT
◆	L.E.D. UP-LIGHTER
◆	INCANDESCENT CEILING MOUNTED LIGHT FITTING
◆	WALL MOUNTED LIGHT FITTING WITH HEIGHT AFFL
DB	DISTRIBUTION BOARD
—	SINGLE SWITCHED CIRCUITS
- - -	MULTI SWITCHED CIRCUITS

PROJECT **PROPOSED NEW HOUSE FOR MR & MRS GURNEY ON ERF 3928 SOLAR BEACH PLETTENBERG BAY**  
 DESCRIPTION **ELECTRICAL LAYOUT**

SCALE: 1:50

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